


**1 STATE MAP**  
SCALE: NTS



**2 LOCATION PLAN**  
SCALE: NTS

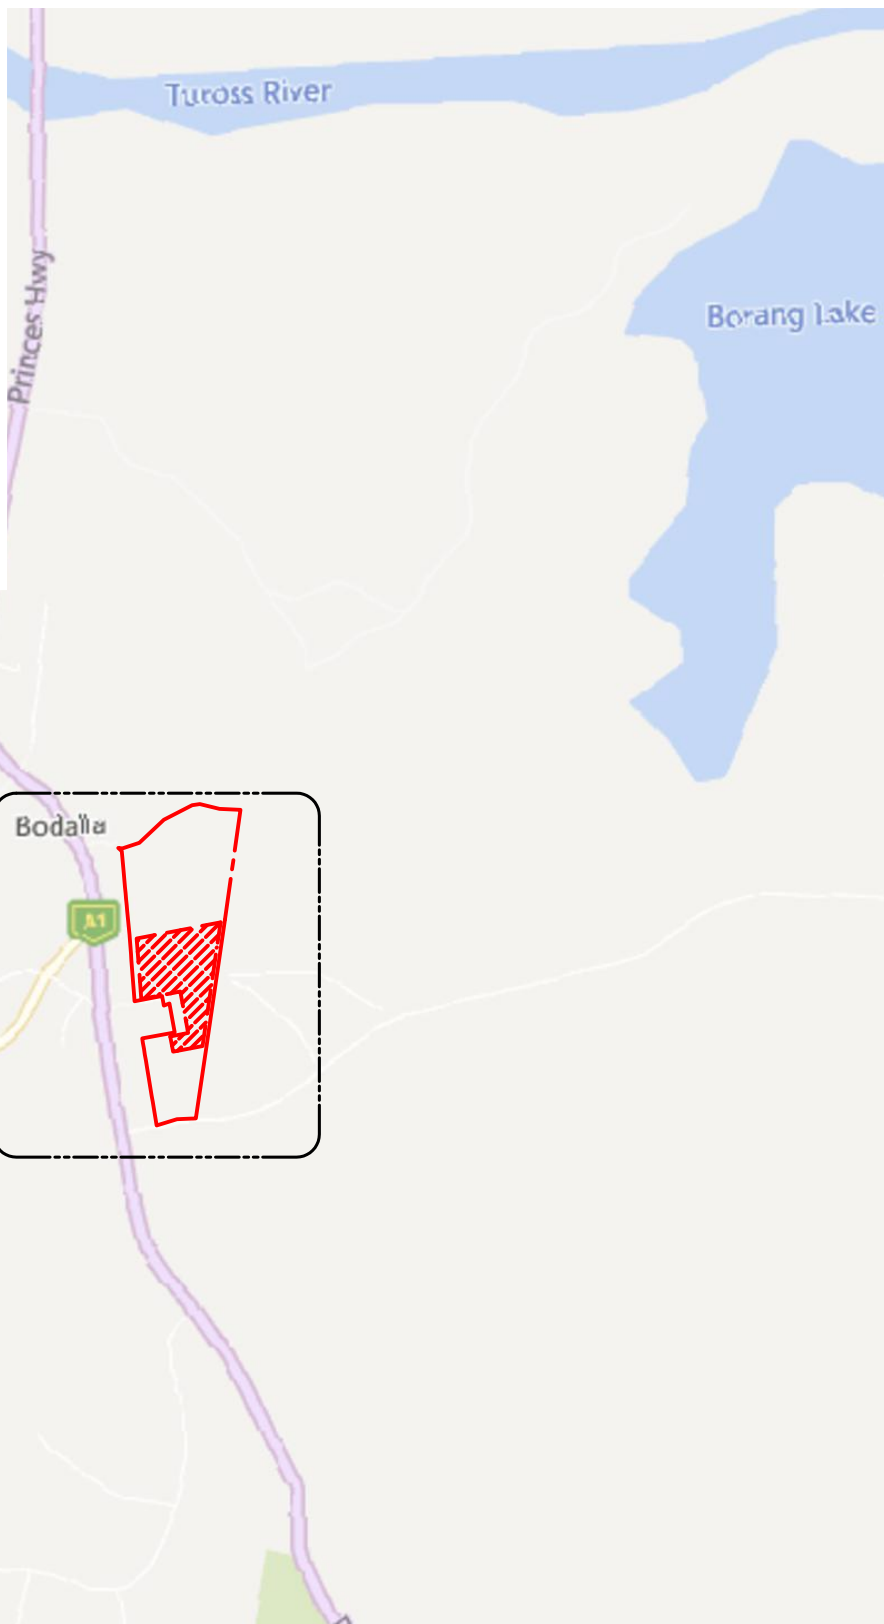

**3 SITE PLAN**  
SCALE: 1:5000

**PRELIMINARY DESIGN**

NO.	STAGE	DSN	DWN	CHKD	APPR	DATE	NOTES
1	PRELIMINARY DESIGN	MOR	MJB	----	----	----	
2	----	----	----	----	----	----	
3	----	----	----	----	----	----	
4	----	----	----	----	----	----	
5	----	----	----	----	----	----	
6	----	----	----	----	----	----	




P: +61 2 6257 3511  
info@itp.com.au  
www.itpau.com.au

PO BOX 6217  
O'CONNOR, ACT 2602  
AUSTRALIA

DSN	MOR	DWN	MJB	DRG TITLE
CHKD	----	APPR	----	<b>LOCATION PLAN</b>
DO NOT SCALE				
ALL MEASUREMENTS IN mm UNLESS OTHERWISE STATED.				PROJECT <b>BODALLA 5MW SOLAR FARM</b>
THIS DOCUMENT MAY ONLY BE USED BY CLIENTS OF ITP OR THOSE WHO HAVE RECEIVED EXPRESS PERMISSION FROM ITP.				CLIENT <b>ANU SURF</b>
THE USE OF THIS DRAWING SHALL NOT EXTEND BEYOND THE PURPOSE FOR WHICH IT WAS ORIGINALLY PREPARED.				ADDRESS <b>LAIDLEY AVE BODALLA, NSW 2545</b>
DRG NO. <b>23002-G-0400</b>				SCALE <b>AS NOTED</b>
				SHEET SIZE <b>A3</b>
				ORIG. DATE <b>7/1/21</b>
				REV. DATE <b>1/5/23</b>
				REV. NO. <b>1</b>



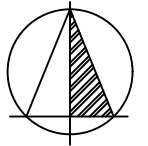

SITE INFORMATION	
LOT / DP	1/1097533
ADDRESS	LAIDLEY AVE, BODALLA, NSW 2545
LGA	EUROBODALLA SHIRE
LAT / LONG	-36.092972 / 150.053409
LOT AREA	26.02 ha
FENCED AREA	6.85 ha
DNSP	ESSENTIAL ENERGY

PROJECT INFORMATION	
DC CAPACITY	8.990 MW
INVERTERS	2 x 2.499 MW AC (4.998 MW)
TABLE SPACING (N-S)	MIN. 1.2 m
TABLE SPACING (E-W)	1.2 m
CONNECTION VOLTAGE	11 kV
CONNECTION FEEDER	ESSENTIAL ENERGY BODC2
CONNECTION SUBSTATION	ESSENTIAL ENERGY BODALLA ZS
SECURITY FENCE SETBACK	MIN. 3 m FROM OPTION BOUNDARY
ARRAY SETBACK	MIN. 10 m FROM SECURITY FENCE
ACCESS PATH WIDTH	4 m

**1 GENERAL ARRANGEMENT PLAN**  
SCALE: 1:2500


**PRELIMINARY DESIGN**

NO.	STAGE	DSN	DWN	CHKD	APPR	DATE	NOTES
1	PRELIMINARY DESIGN	MOR	MJB	----	----	----	
2	----	----	----	----	----	----	
3	----	----	----	----	----	----	
4	----	----	----	----	----	----	
5	----	----	----	----	----	----	
6	----	----	----	----	----	----	




DSN	MOR	DWN	MJB	DRG TITLE
CHKD	----	APPR	----	<b>GENERAL ARRANGEMENT PLAN</b>
DO NOT SCALE				
ALL MEASUREMENTS IN mm UNLESS OTHERWISE STATED.				PROJECT BODALLA 5MW SOLAR FARM
THIS DOCUMENT MAY ONLY BE USED BY CLIENTS OF ITP OR THOSE WHO HAVE RECEIVED EXPRESS PERMISSION FROM ITP.				SCALE AS NOTED
THE USE OF THIS DRAWING SHALL NOT EXTEND BEYOND THE PURPOSE FOR WHICH IT WAS ORIGINALLY PREPARED.				SHEET SIZE A3
CLIENT ANU SURF				ORIG. DATE 15/6/22
ADDRESS LAIDLEY AVE				REV. DATE 30/5/23
BODALLA, NSW 2545				REV. NO. 1
DRG NO. 23002-G-2100				



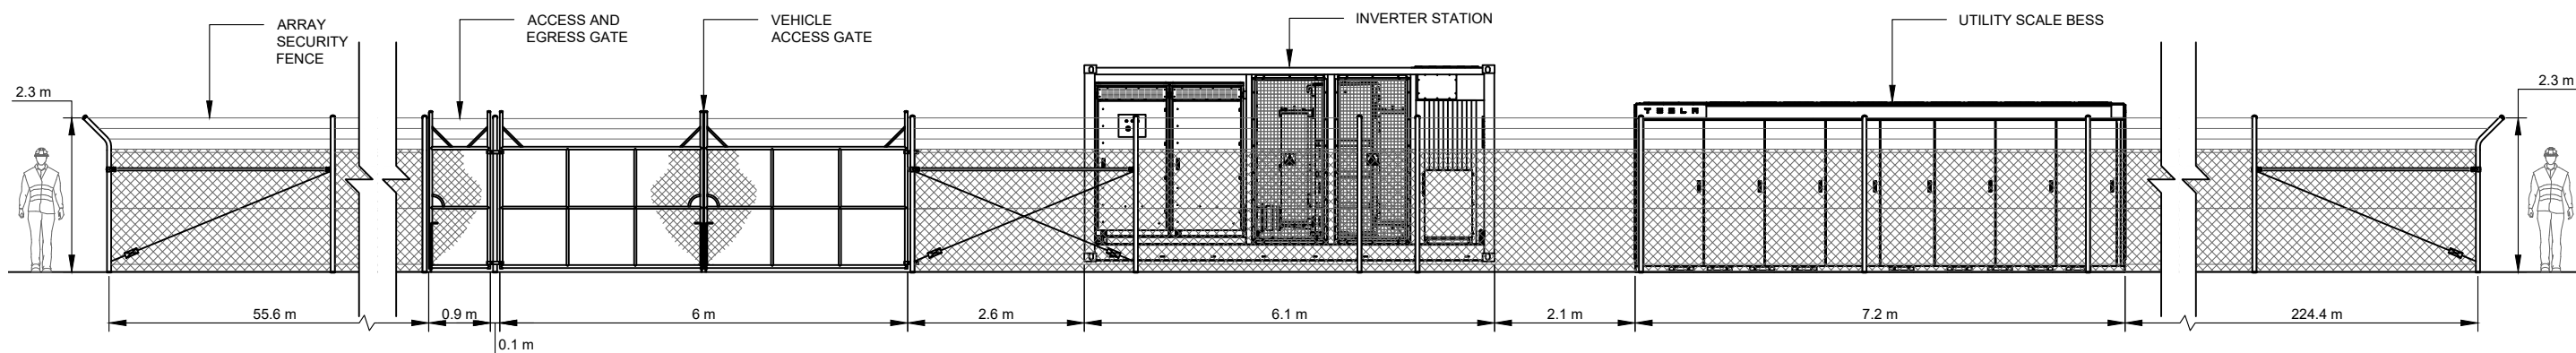

**A** ELEVATION A  
G-2100 SCALE: 1:100

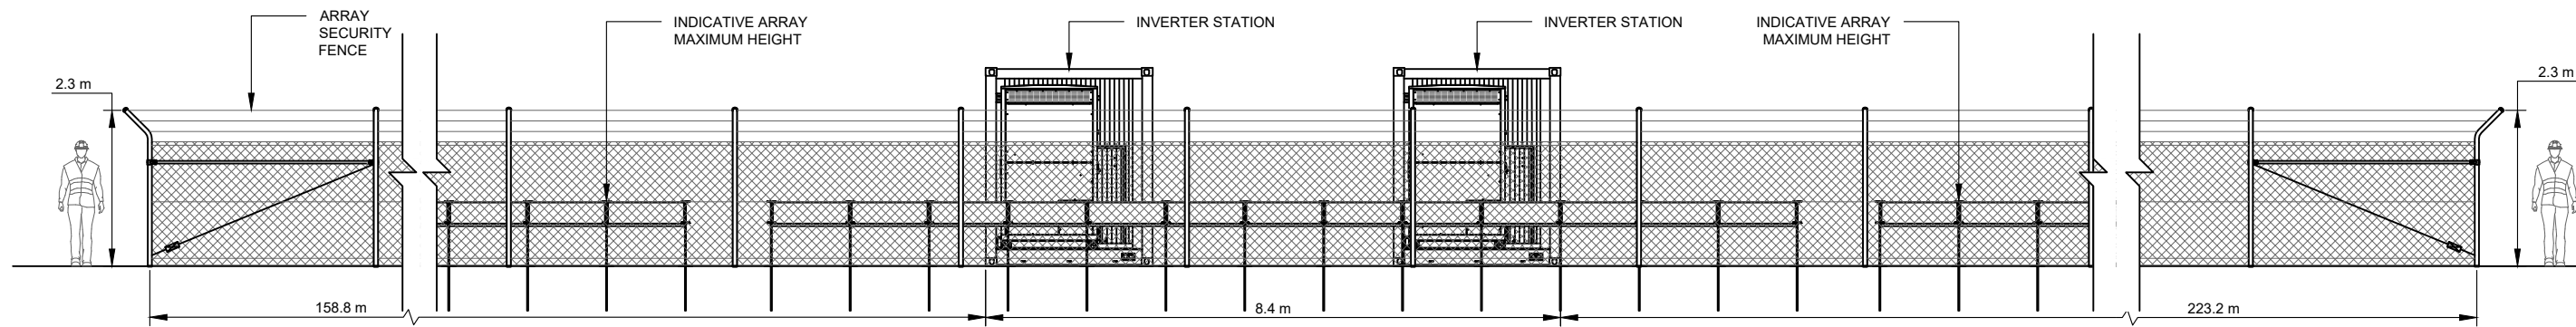

**B** ELEVATION B  
G-2100 SCALE: 1:100

**PRELIMINARY DESIGN**

NO.	STAGE	DSN	DWN	CHKD	APPR	DATE	NOTES
1	PRELIMINARY DESIGN	MOR	MJB	----	----	----	
2	----	----	----	----	----	----	
3	----	----	----	----	----	----	
4	----	----	----	----	----	----	
5	----	----	----	----	----	----	
6	----	----	----	----	----	----	



DSN MOR DWN MJB  
CHKD ---- APPR ----  
**DO NOT SCALE**  
ALL MEASUREMENTS IN mm UNLESS OTHERWISE STATED.  
THIS DOCUMENT MAY ONLY BE USED BY CLIENTS OF ITP OR THOSE WHO HAVE RECEIVED EXPRESS PERMISSION FROM ITP.  
THE USE OF THIS DRAWING SHALL NOT EXTEND BEYOND THE PURPOSE FOR WHICH IT WAS ORIGINALLY PREPARED.

DRG TITLE		SCALE	
<b>SITE ELEVATIONS</b>		AS NOTED	
PROJECT BODALLA 5MW SOLAR FARM		SHEET SIZE A3	
CLIENT ANU SURF		ORIG. DATE 2/12/20	
ADDRESS LAIDLEY AVE BODALLA, NSW 2545		REV. DATE 30/5/23	
DRG NO. 23002-G-2200		REV NO. 1	